COMMITTEE OF THE WHOLE - AUGUST 31, 2010

SIGN VARIANCE APPLICATION

FILE NO: SV.10-029

OWNER: FIRST CAPITAL (YIFAT RINGEL)

LOCATION: 9320 BATHURST STREET

BLOCK 23, REGISTERED PLAN 65M-3918

WARD 1

Recommendation

The Sign Variance Committee recommends:

That Sign Variance Application SV.10-029, First Capital (Yifat Ringel), be APPROVED for the Harvey's wall on the north elevation.

Contribution to Sustainability

N/A

Economic Impact

None.

Communications Plan

The results of this application will be communicated to the applicant through the Secretary to the Sign Variance Committee.

Purpose

Request to install an additional wall sign on the building face of the subject property as shown on the attached drawings.

Background - Analysis and Options

Bylaw Requirements (203-92, as amended):

6.2 (a) Where a site plan approved by the City provides standards for signage and the signs for the development comply therewith, such signs shall be deemed to comply with this By-Law.

Noting the above, where the property is regulated by a site plan agreement approved by the City, only those wall signs and pylon signs approved under the site plan agreement are deemed to be permitted by the City's Sign By-Law.

Relationship to Vaughan Vision 2020/Strategic Plan

This report is consistent with the priorities previously set by Council and the necessary resources have been allocated and approved.

Regional Implications

Region of York Engineering approval is not required for the proposed signs.

Conclusion

The applicant is proposing to install a wall sign on the building face as shown on the attached drawings. The proposed sign is not shown on the approved site plan agreement and therefore a sign variance is required.

Members of the Sign Variance Committee have reviewed the application and have no objections to the application as submitted. Committee members are of the opinion that the intent and purpose of the sign by-law is being maintained.

If Council finds merit in the application a Sign Permit issued by the Building Standards Department is required.

<u>Attachments</u>

- 1. Site Plan
- 2. Sketch of Sign

Report prepared by:


John Studdy, Manager of Customer & Administrative Services Ext 8232

Respectfully submitted,

John Studdy Chair, Sign Variance Committee

/pa

3V.10-029

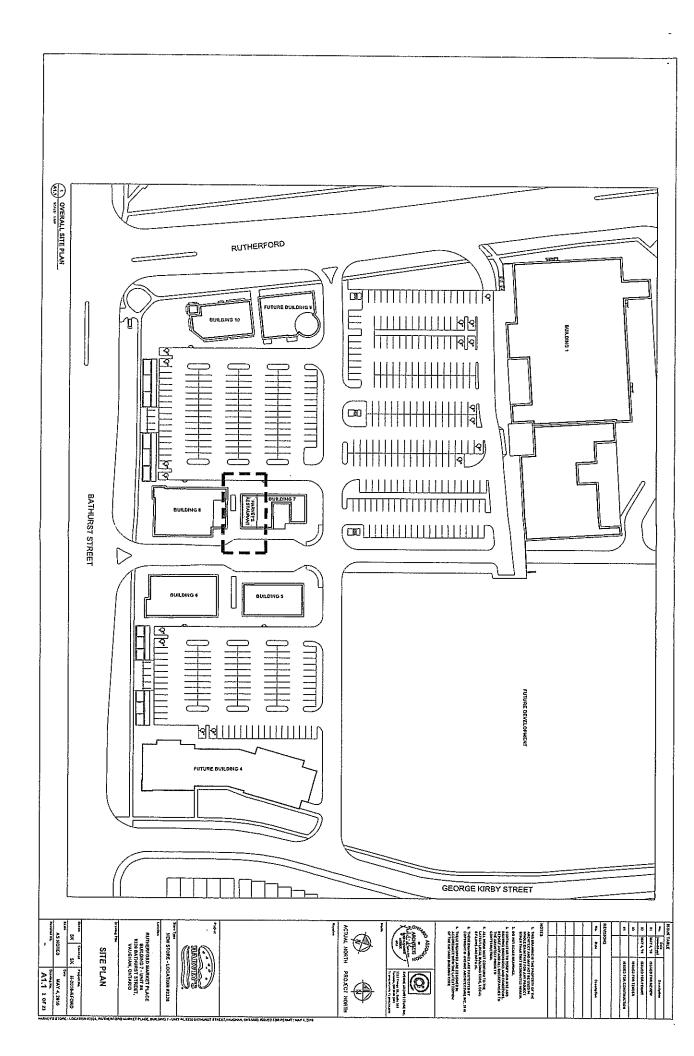

℗ 4 1/2 CROSS SECTION A-A LED LAYOUT SCALE- N.T.S. SCALE- N.T.S. FRONT ELEVATION VIEW 넮 囱 Θ 1/4" SPACE for AIR CIRCULATION Θ CAL 128 EXISTING PARAPET BRICK WALL 2 1/2" LONG TAP CON Support Shelf for POWER SUPPLY Electrical Lead to 120V 3/16" 2119 ACRYLIC FACES with Vinyls Applied 5/8" SEAL BUSHINGS .081 Aluminum BACKS LED MODULE BY SLOAN 1" VINYL SILVATRIM TO MATCH PMS#2757 BLUE .040 Aluminum RETURNS - BLACK 12 VOLTS DC (250 VA) SECONDARY 120V REMOTE TRANSFORMER 14'-10 7/8" DESIGN WIND PRESSURE IS 18 PSF (SUCTION)
ICE LOAD OD 31MM APPLIED TO FACE AREA OF WALL SIGNS INSTALL HILTI ANCHORS PER MFG INSTRUCTIONS AND RECOMMENDATIONS MOUNTING BOLTS TO SAE GRADE 2 OR STAINLESS STEEL TYPE 304 OR 316 208.40 CY 125 % THE STATE OF THE PROPERTY OF T **NORTH ELEVATION VIEW - N.T.S** SLOAN MIN. 5 FASTENERS PER LETTER
FASTENERS TO HAVE OVERSIZED WASHERS AND TO BE LOCATED NEAR TOP & BOTTOM EDGES PRESENT MELAY CAS THE PARTIES IN THE PROPERTY OF ANY NETTER CONTROL OF THE PARTIES O LOCATION: HARVEYS # 2328 9320 BATHURST ST. VAUGHAN, ON DESCRIPTION; CHARRIEL LETTERS FILE NAME; ILLUMINATED CHARRIEL LETTERS SIGNS CLETOMER: HARVEYS MAX. WEIGHT OF THE LETTER IS 5 LBS NOTES: SLOAN LED ORANGE 103 MODULES SLOAN LED RED 46 MODULES 2- CV 125 POWER SUPPLY 120VA (12V) @1.0 AMPS EACH (90 MAX.) TOTAL 120V 2.00 AMPS LOAD 1-15 AMPS CIRCUIT REGUIRED 120V ELECTRICAL DETAILS: TRANSPORTATION VITALITY OF VI SCALE: AS NOTED DRAWN BY: M. MALING APPROVED IN: L store DWG, SIZE : Ž, DATE: 04 JUNE 2010 DAY HITE SIGHS CANADA DIC.

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